

DEVELOPMENT APPLICATION AND CONSTRUCTION CERTIFICATE

PROPOSED STABLE SHADE STRUCTURE, FARM SHEDS AND RETAINING WALL



CONTINUED USE OF EXISTING STABLES,FOR:

THOMAS WORTH

LOT 42, DP1281377

24 RUPRECHTS ROAD

MITCHELLS ISLAND, NSW, 2430

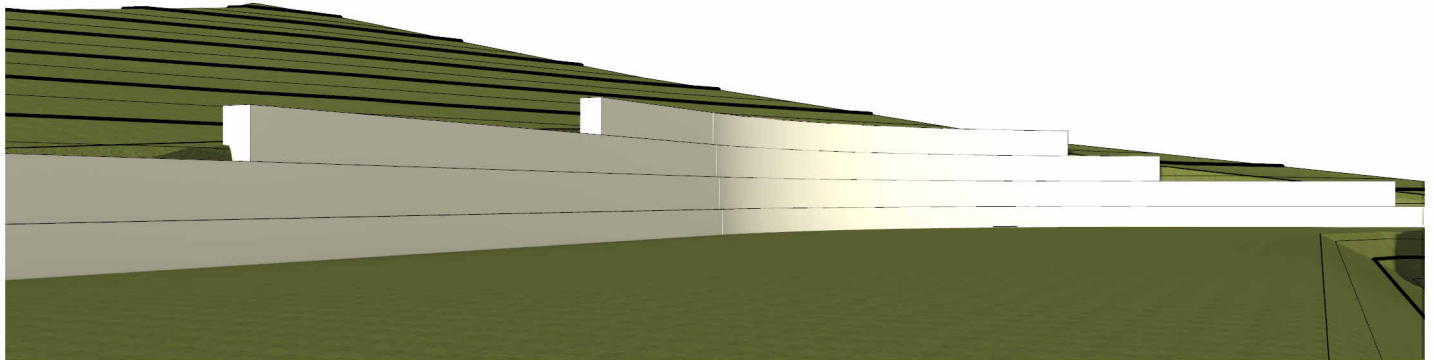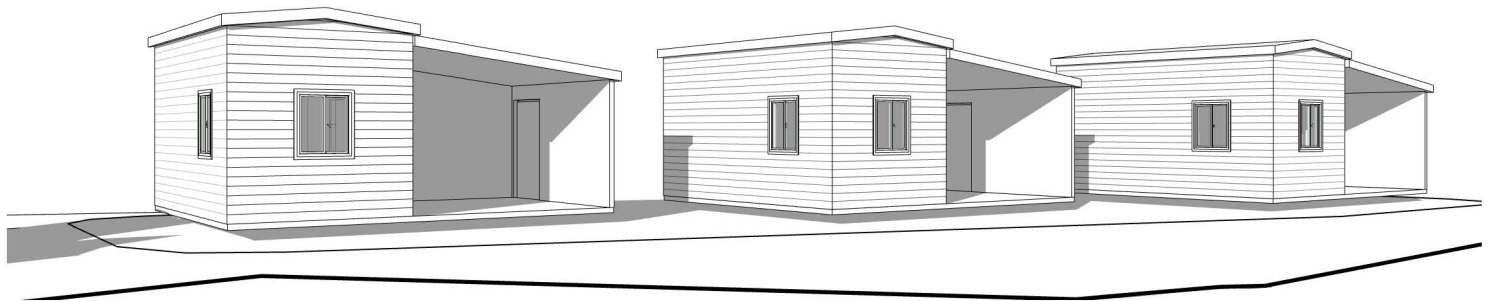

Sheet List	
Sheet Number	Sheet Name
00	COVER SHEET
01	SPECIFICATIONS
02	DETAIL SITE PLAN
03	FULL SITE PLAN
04	SITE PLAN DETAIL
05	STABLES FLOOR PLAN

Revision Schedule		
Rev	Amendment	Date
A	Concept Plan	22/11/23
B	Council Issue	05/03/25



Site Area		
Name	Area	Percentage Of Area Used
Site Remaining	50548.25 m ²	97.9%
Built Area	570.45 m ²	1.1%
Stables	162.48 m ²	0.3%
Hay Shed	180.00 m ²	0.3%
Barn Area	159.55 m ²	0.3%
Grand total: 5	51620.73 m ²	100.0%

FLOOD LEVEL DETAILS

FPL4 PROBABLE MAX FLOOD LEVEL - 5.5m AHD

1% AEP FLOOD LEVEL IN YEAR 2010 - 2.9m AHD


1% AEP FLOOD LEVEL IN YEAR 2050 - 3.2m AHD

FPL2 1% AEP FLOOD LEVEL PLANNING IN YEAR 2100 - 3.5m AHD

FPLL3 FLOOD PLANNING LEVEL - 4.0m AHD - 1% FLOOD LEVEL PLUS 0.5m FREEBOARD

FPL1 5% OF AEP FLOOD LEVEL - 1.6m AHD

- (C) - EASEMENT FOR OVERHEAD TRANSMISSION LINE 10 WIDE (VIDE DP1081422)
- (D) - EASEMENT FOR OVERHEAD TRANSMISSION LINE 5 WIDE (VIDE DP1081422)
- (R) - RIGHT OF CARRIAGEWAY 10 WIDE (VIDE DP1081422)
- (T) - EASEMENT FOR OVERHEAD TRANSMISSION LINE 20 WIDE (VIDE DP1081422)
- (W) - EASEMENT FOR WATER SUPPLY 28.645 WIDE (VIDE DP1279979)

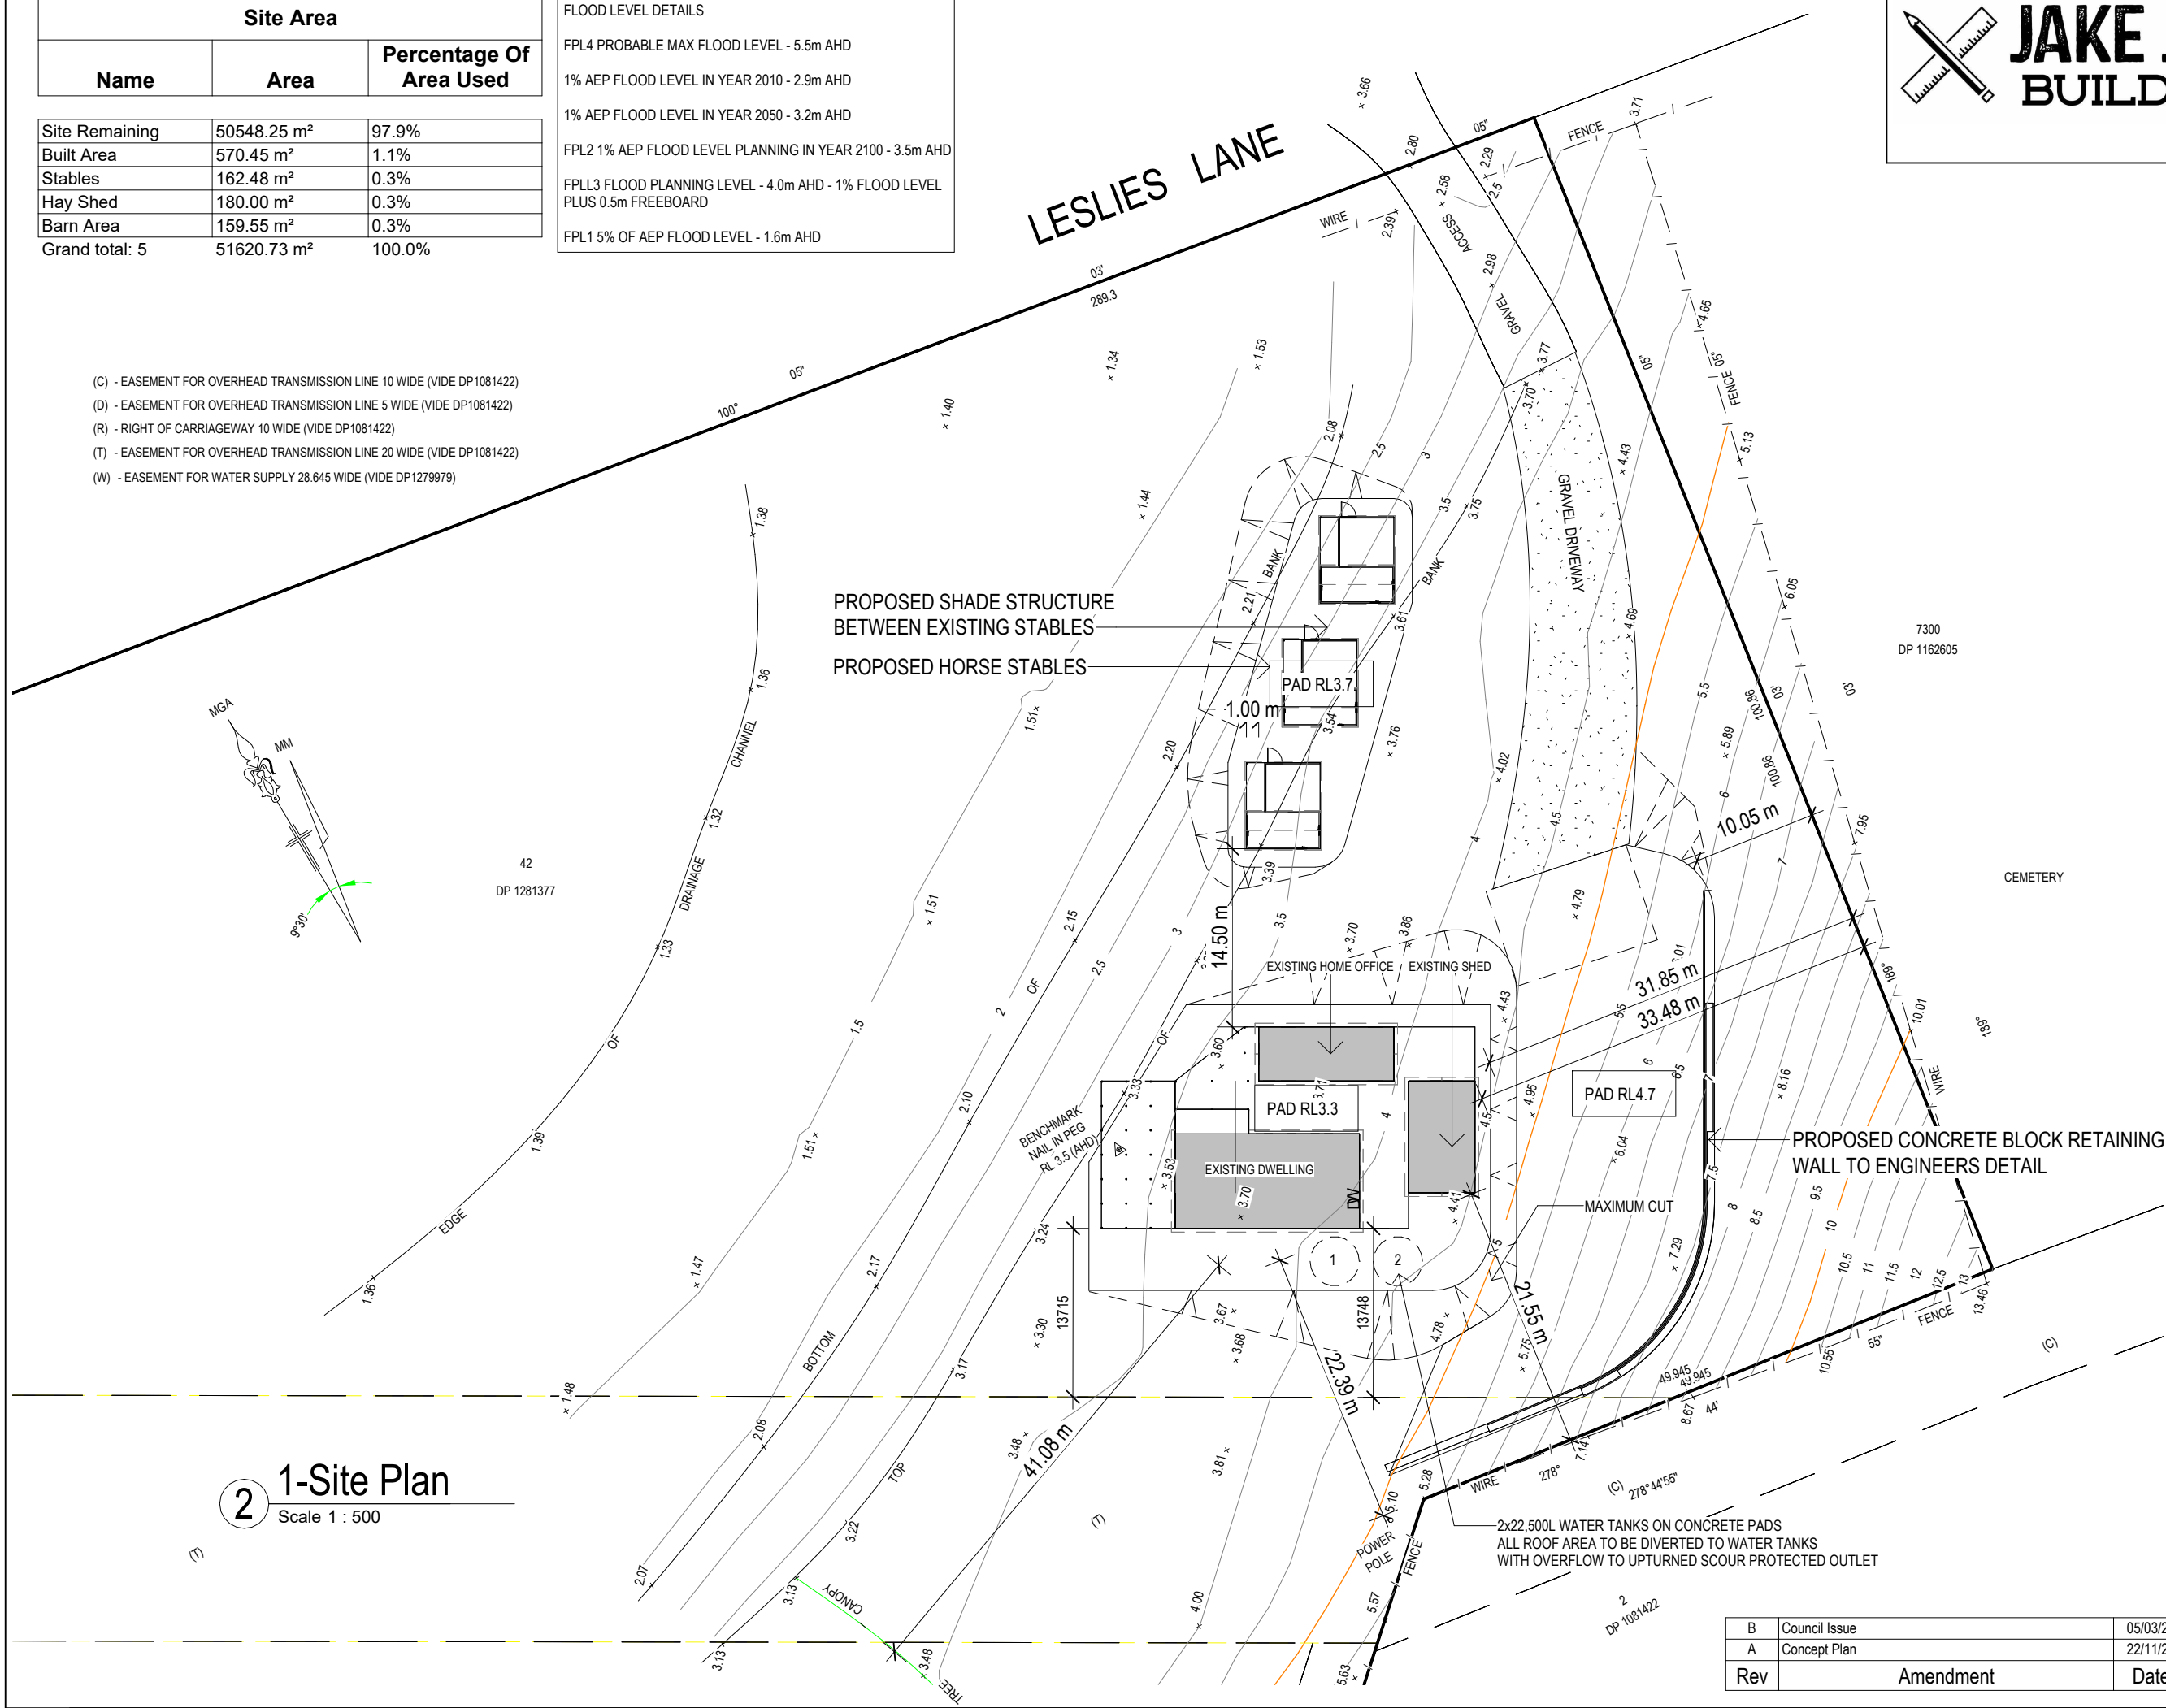

2 1-Site Plan
Scale 1 : 500



JAKE JOHNSTON
BUILDING DESIGN

JAKE JOHNSTON BUILDING DESIGN
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jakejohnstonbuildingdesign@gmail.com

SUITE 5, RANATAN BUSINESS
CENTRE, BELGRAVE STREET,
KEMPSEY, NSW, 2440

ENGINEER

PROPOSED DWELLING

FOR THOMAS WORTH

AT LOT 42, DP1281377
24 RUPRECHTS
ROAD
MITCHELLS
ISLAND, NSW, 2430


STANDARD NOTES:
ALL ARCHITECTURAL DRAWINGS TO
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VERIFY ALL DIMENSIONS BEFORE
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SPECIFIED.

BASIX CERT. No.	N/A
TITLE	DETAIL SITE PLAN
PLAN	SHEDS & RETAINING WALL
DATE	05/03/25
SCALE	1 : 500
DRAWN	J.A.J

JOB No. DRAWING No.

353-JJBD 02

B	Council Issue	05/03/25
A	Concept Plan	22/11/23
Rev	Amendment	Date

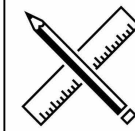

JAKE JOHNSTON BUILDING DESIGN

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RUPRECHTS
ROAD

PROPOSED HAY SHED

PROPOSED BARN

EXISTING TREES TO REMAIN

EXISTING DWELLING

EXISTING HOME OFFICE

CONTINUED USE OF STABLES

EXISTING DRIVEWAY

EXISTING POTTERY WORKSHOP

PROPOSED CONCRETE BLOCK RETAINING WALL

FLOOD LEVEL DETAILS

FPL4 PROBABLE MAX FLOOD LEVEL - 5.5m AHD

1% AEP FLOOD LEVEL IN YEAR 2010 - 2.9m AHD

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BASIX
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TITLE
FULL SITE
PLAN

PLAN
SHEDS &
RETAINING
WALL

DATE
05/03/25

SCALE
1 : 2000

DRAWN
J.A.J

JOB No. DRAWING No.

353-JJBD 03

B	Council Issue	05/03/25
A	Concept Plan	22/11/23
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1 1-Full Site Plan

Scale 1 : 2000

LOCATION PLAN
RR: 1:1200

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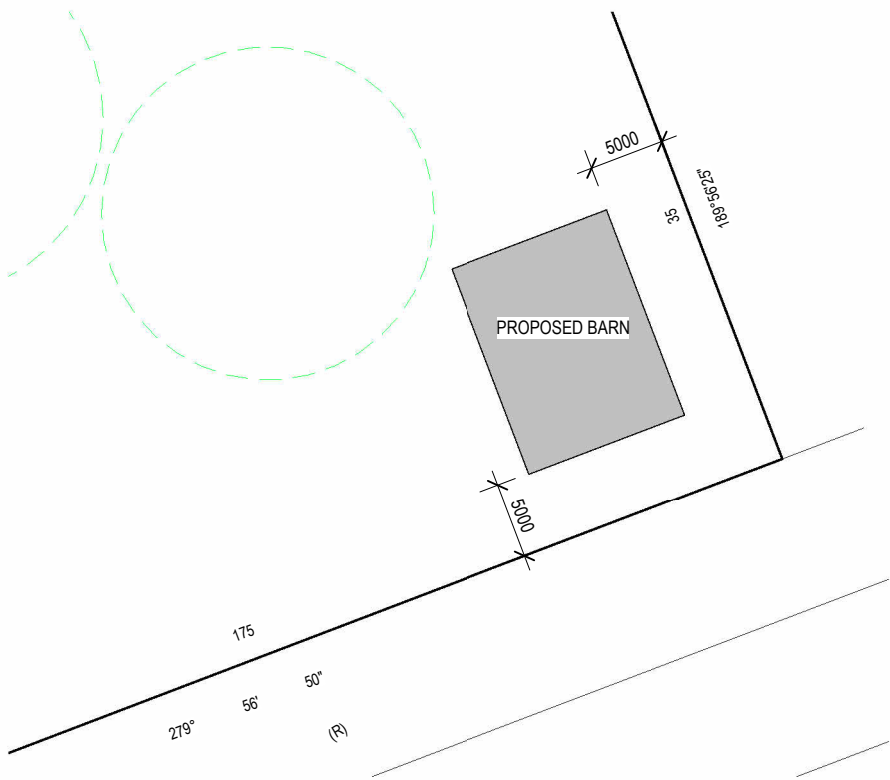
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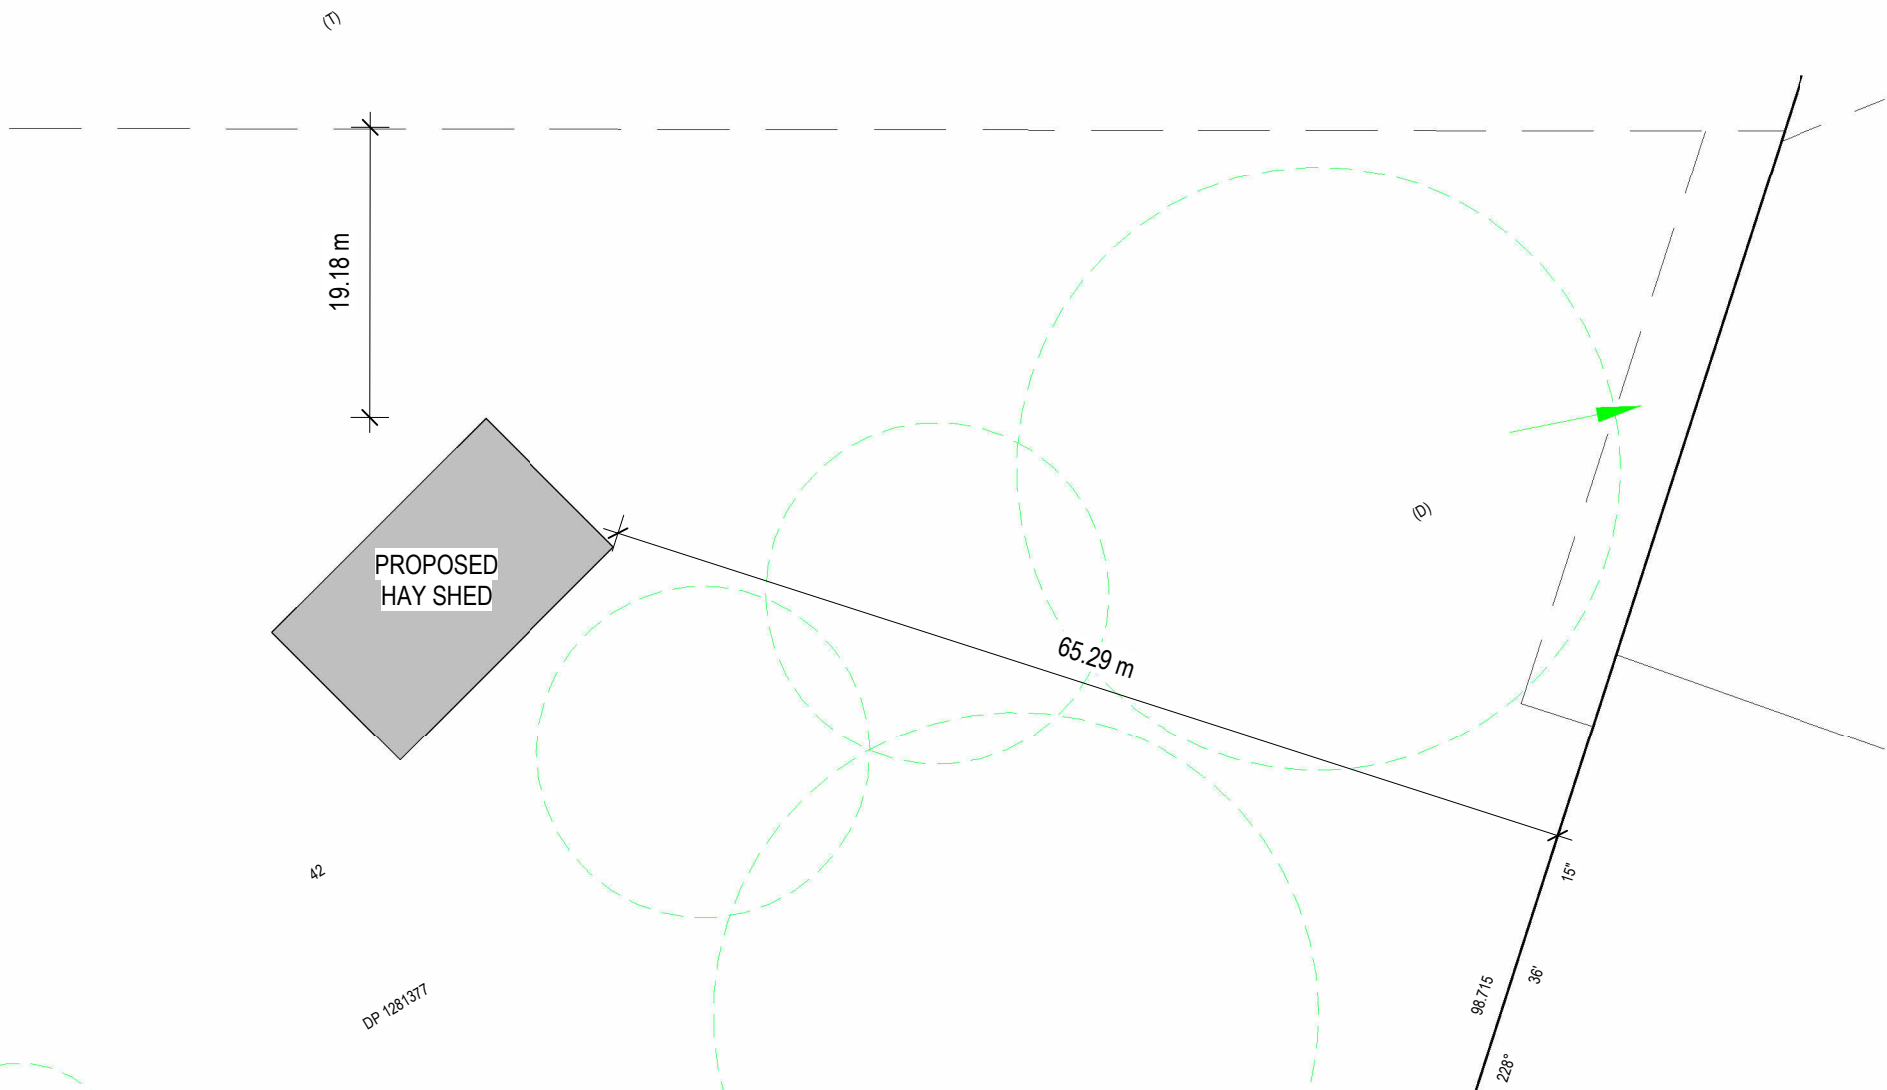
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PLAN	SHEDS & RETAINING WALL
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JOB No. DRAWING No.

353-JJBD 04



1 1-Barn Detail Site Plan
Scale 1 : 500



2 1-Hay Shed Detail Site Plan
Scale 1 : 500

Rev	Amendment	Date
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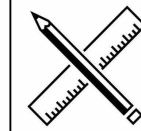
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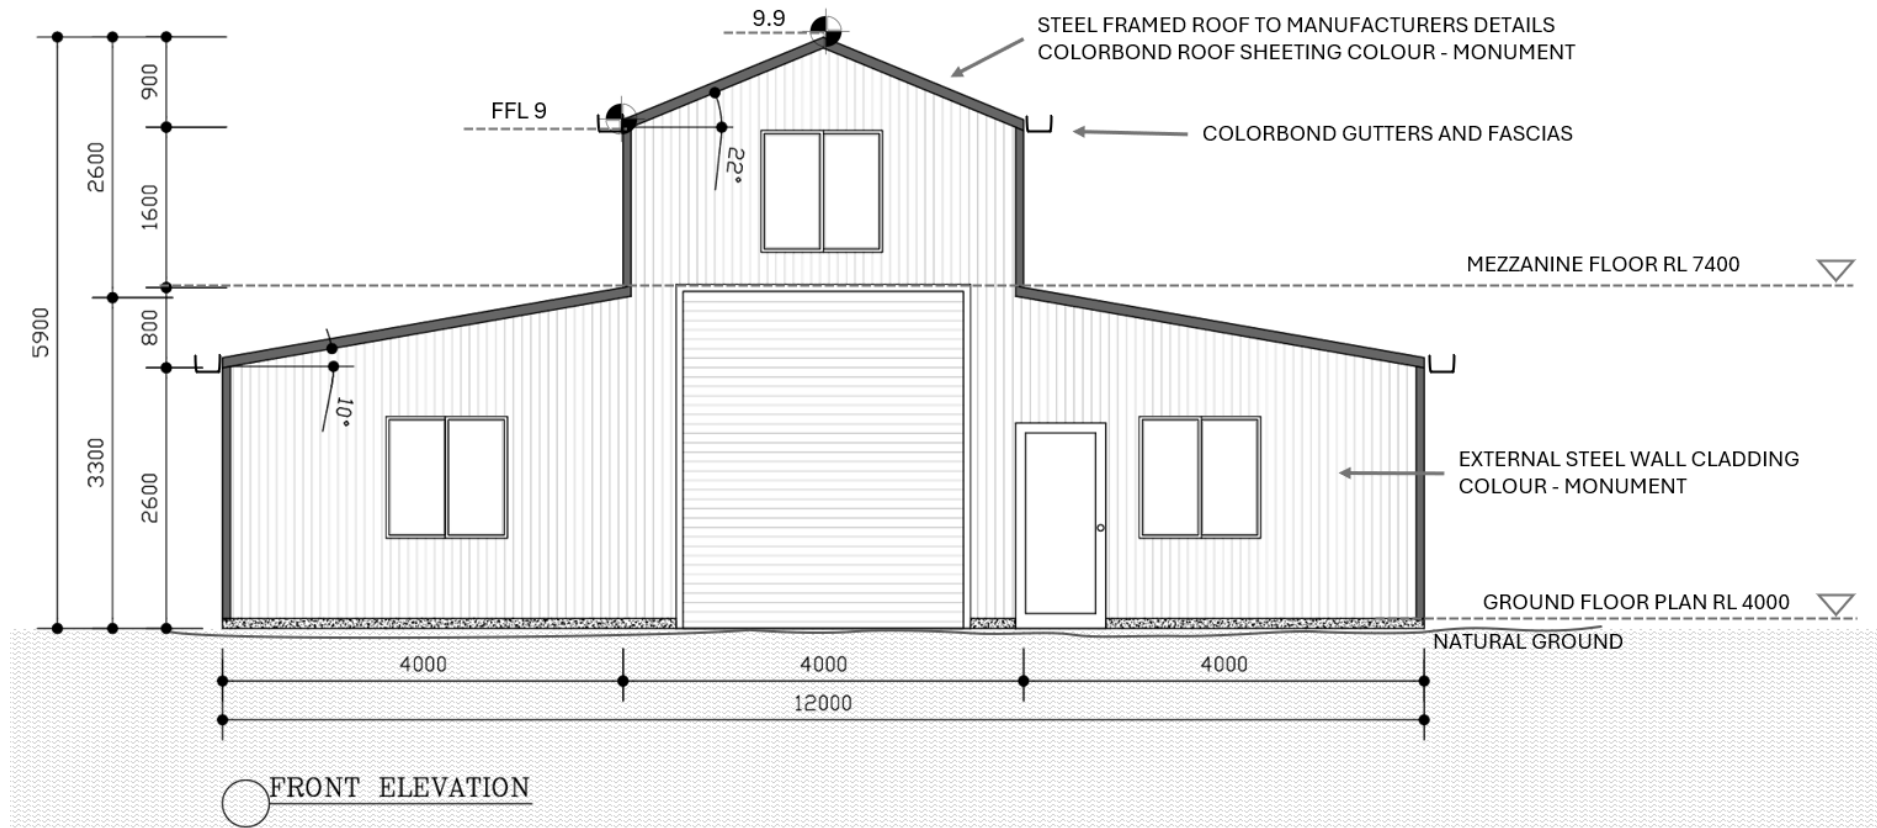
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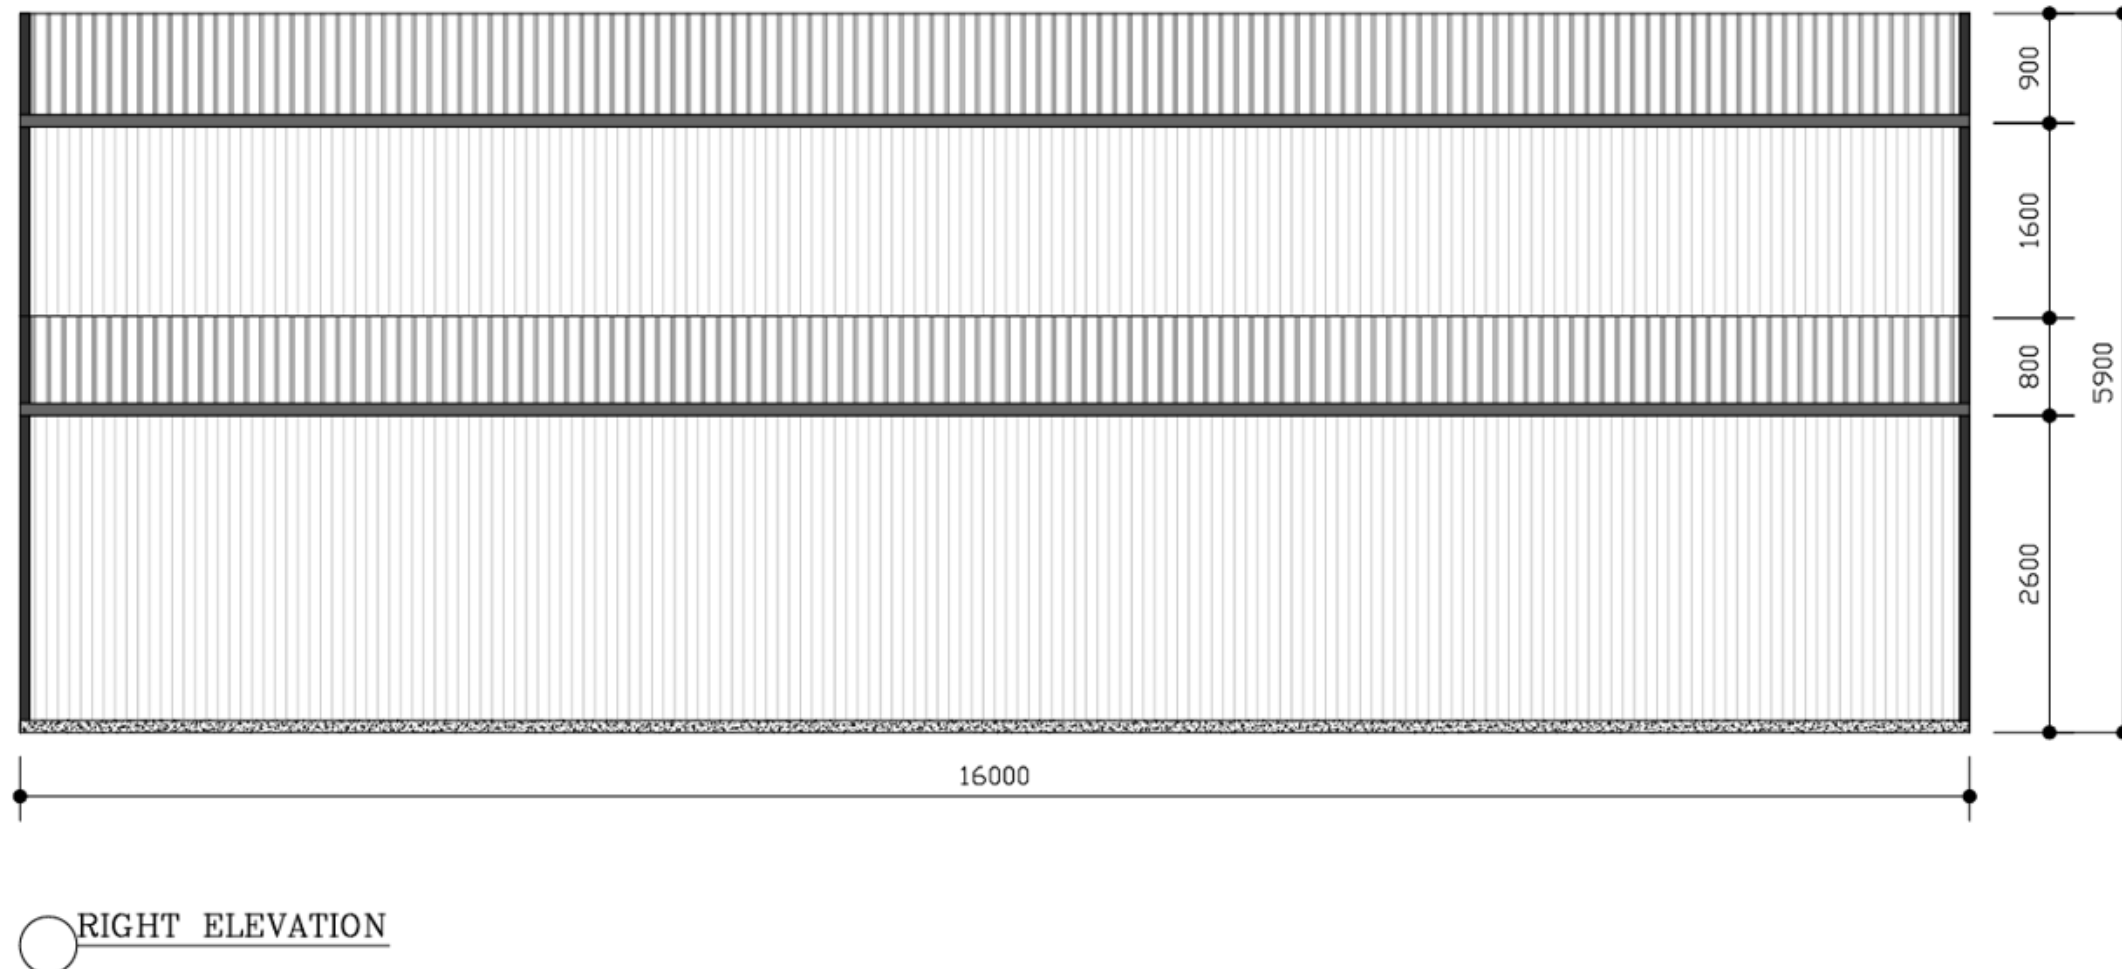
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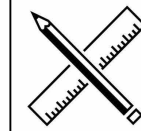
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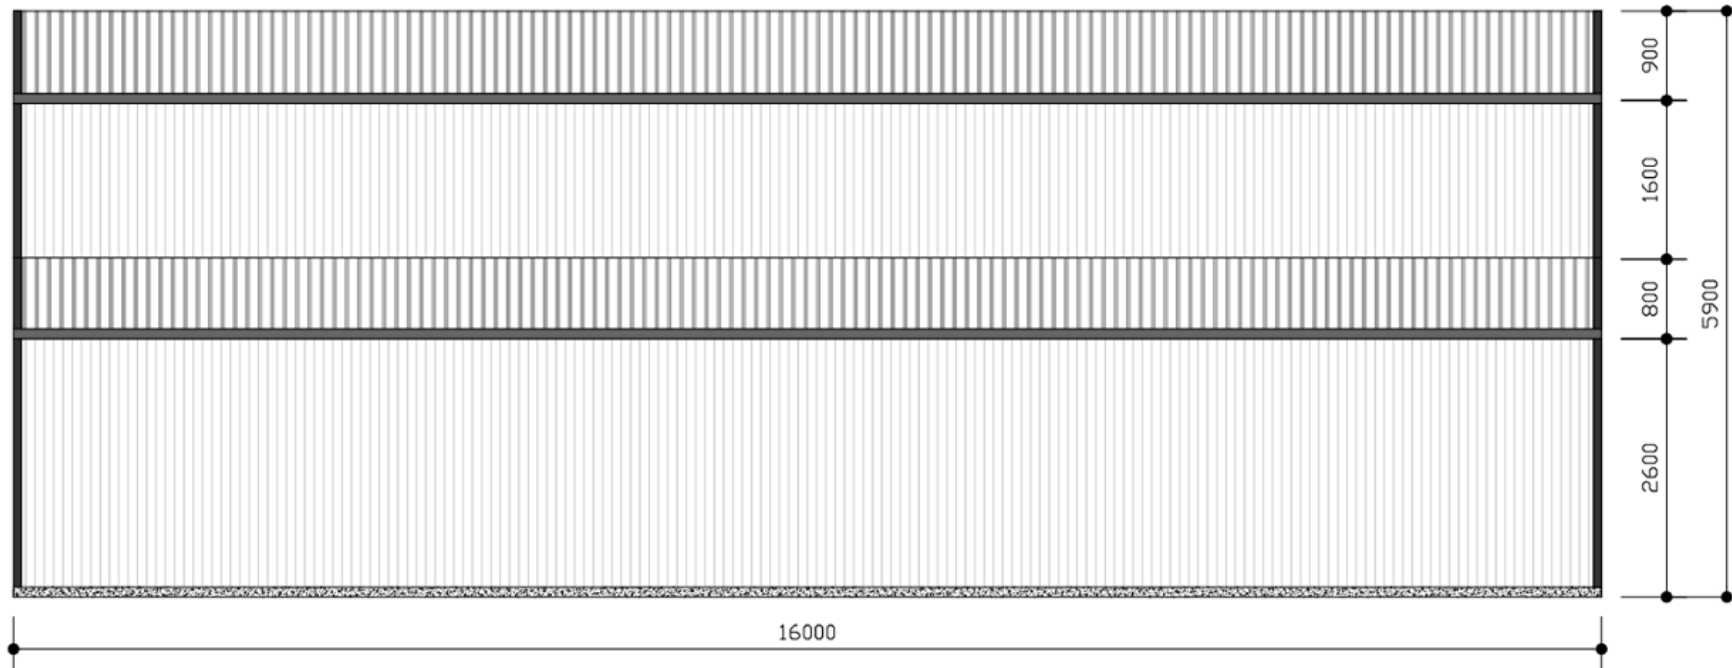
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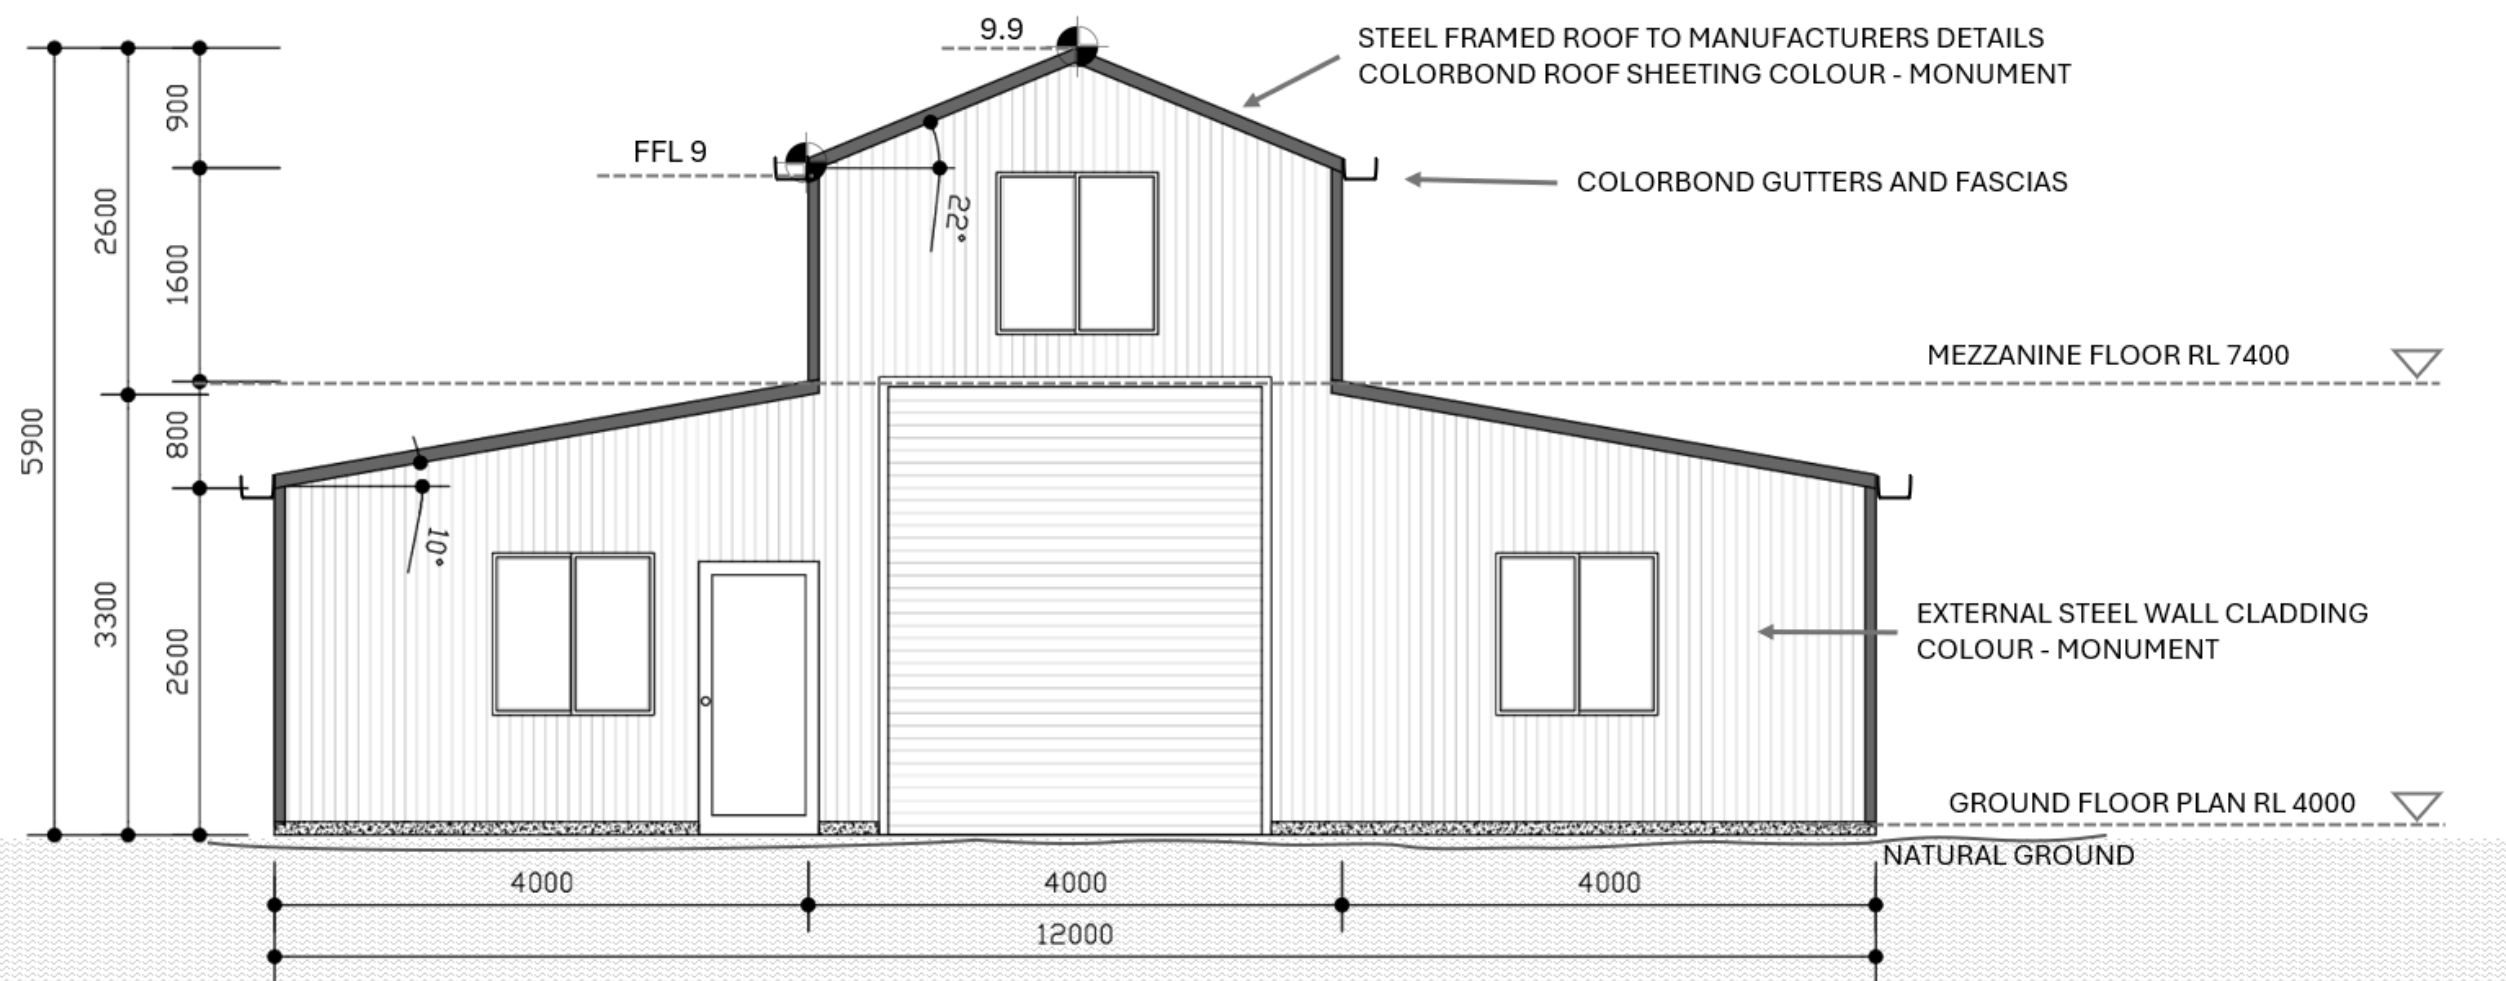
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353-JJBD 04



LEFT ELEVATION



REAR ELEVATION

Rev	Amendment	Date
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1.0 GENERAL NOTES:

- 1.1. THESE DRAWINGS SHALL BE READ IN CONJUNCTION WITH ALL ARCHITECTURAL AND OTHER CONSULTANT'S DRAWINGS & SPECIFICATIONS AND OTHER WRITTEN INSTRUCTIONS ISSUED DURING THE COURSE OF THIS CONTRACT. ALL DISCREPANCIES SHALL BE REFERRED TO THE SUPERINTENDENT AND AWAIT CLARIFICATION BEFORE PROCEEDING WITH THE WORK.
- 1.2. ALL LEVELS AND DIMENSIONS RELEVANT TO SETTING OUT AND OFF-SITE WORK SHALL BE VERIFIED BY THE BUILDER BEFORE CONSTRUCTION AND FABRICATIONS IS COMMENCED. THE ENGINEER'S DRAWINGS SHALL NOT BE SCALED.
- 1.3. ALL LEVELS AND LOCATIONS INDICATED IN THIS DRAWING ARE BASED ON THE INFORMATION PROVIDED BY THE BUILDER.
- 1.4. FINAL LEVELS AND LOCATIONS SHOULD BE VERIFIED BY A REGISTERED LICENSED SURVEYOR THROUGH A DETAILED TOPOGRAPHICAL SURVEY PRIOR TO THE CONSTRUCTION.
- 1.5. IF ANY DISCREPANCIES OR CHANGES IN LEVELS OR SITE CONDITIONS ARE IDENTIFIED DURING THE SURVEY OR CONSTRUCTION, THE BUILDER MUST IMMEDIATELY NOTIFY THE STRUCTURAL ENGINEER FOR REASSESSMENT AND POSSIBLE DESIGN ADJUSTMENTS.
- 1.6. DURING THE CONSTRUCTION, THE BUILDER SHALL BE RESPONSIBLE FOR MAINTAINING THE STRUCTURE IN A STABLE CONDITION/ PROPER ALIGNMENT AND EXCAVATION TO THE LEVELS/ AND LOCATIONS AS VERIFIED BY THE SURVEYOR, AND IF IN DOUBT, CONSULT THE ENGINEER. ANY UNAUTHORISED MODIFICATIONS TO THE RETAINING WALL DESIGN ARE STRICTLY PROHIBITED AND MAY COMPROMISE STRUCTURAL INTEGRITY.
- 1.7. STABILITY OF ALL EXCAVATIONS INCLUDING EXCAVATIONS IN THE VICINITY OF NEIGHBOURING BUILDINGS IS THE RESPONSIBILITY OF THE BUILDER, APPROVAL OF ALL PROPOSALS MUST BE GRANTED IN WRITING PRIOR TO COMMENCEMENT OF SUCH WORK.
- 1.8. ADEQUATE DRAINAGE BEHIND THE RETAINING WALL IS CRITICAL TO ITS PERFORMANCE. CONSULT THE STRUCTURAL ENGINEER IF ON-SITE CONDITIONS DEVIATE FROM THE DESIGN.
- 1.9. UNLESS OTHERWISE SPECIFIED, MATERIALS, CONSTRUCTION TOLERANCES AND WORKMANSHIP ARE TO BE IN ACCORDANCE WITH ALL RELEVANT AUSTRALIAN STANDARDS AND ENGINEERING SPECIFICATIONS INCLUDING CURRENT AMENDMENTS, STATUTORY AUTHORITIES REGULATIONS AND BY-LAWS AND THE BUILDING ACT. ANY DEVIATIONS BEYOND PERMISSIBLE TOLERANCES SHOULD BE REPORTED TO THE STRUCTURAL ENGINEER.
- 1.10. THIS DESIGN ASSUMES SOIL CONDITIONS ARE AS PER THE PROVIDED GEOTECHNICAL REPORT BY IDEAL GEOTECH. ANY UNEXPECTED GROUND CONDITIONS MUST BE COMMUNICATED TO THE STRUCTURAL ENGINEER IMMEDIATELY.
- 1.11. BUILDER TO COMPLY WITH HEALTH AND SAFETY REGULATIONS AT ALL TIMES DURING CONSTRUCTION AND INSPECTIONS. AND ALL OTHER CONSTRUCTION WORKS MUST COMPLY WITH LOCAL COUNCIL REGULATIONS AND RELEVANT AUSTRALIAN STANDARDS. THE RETAINING WALL DESIGN MUST BE CERTIFIED BEFORE COMMENCING CONSTRUCTION IF REQUIRED BY LOCAL AUTHORITY.


2.0 CONCRETE NOTES:

- 2.1. MATERIALS, WORKMANSHIP AND TESTING SHALL COMPLY WITH AS 1379, AS 3600 & AS 3610.
- 2.2. WATER MUST NOT BE ADDED TO THE PREMIXED CONCRETE AT SITE AND NO ADDITIVES OR ADMIXTURES TO BE USED WITHOUT OBTAINING PRIOR APPROVAL IN WRITING FROM THE ENGINEER.


A) THE FOLLOWING STRUCTURAL COMPONENTS SHALL HAVE THE FOLLOWING CONCRETE STRENGTH CHARACTERISTICS:

FOOTING	20 MPa	100 SLUMP	20mm MAX. AGGREGATE
SLAB ON GROUND	25 MPa	80 SLUMP	20mm MAX. AGGREGATE
SUSPENDED SLAB	32 MPa	80 SLUMP	20mm MAX. AGGREGATE

B) LAP SPLICES FOR FABRIC (MESH) IN TENSION SHALL BE MADE SO THAT THE OUTER MOST TRANSVERSE WIRES OF ONE SHEET OF FABRIC OVERLAP THE TWO OUTERMOST TRANSVERSE WIRES OF THE SHEET BEING LAPPED, AS SHOWN IN THE FIGURE BELOW. ALL FABRIC (MESH) SHALL BE $F_y = 500$ MPa.

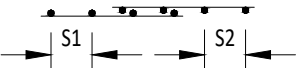

A) $S1 = S2$

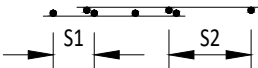

B) $S1 < S2$

2.3. CONCRETE COVER TO REINFORCEMENT (REFER TABLE 4.10.3.2 OF AS 3600) UNLESS OTHERWISE SHOWN SHALL BE AS FOLLOWS:
- 2.0 CONCRETE NOTES (CONTINUED):
- | BUILDING ELEMENT | CONCRETE COVER (mm) | |
|------------------|---------------------|----------|
| | INTERNAL | EXTERNAL |
| FOOTINGS | 50 GENERALLY | |
| SLAB ON GROUND | 30 TOP | 40 TOP |

2.4. NO CHEMICAL ADMIXTURES TO BE USED IN THE CONCRETE WITHOUT THE SUPERINTENDENT'S PRIOR APPROVAL.

2.5. SIZE OF ELEMENTS IS EXCLUSIVE OF APPLIED FINISHES. BEAM DEPTHS INCLUDE SLAB THICKNESS & ARE THE FIRST DIMENSION SPECIFIED FOLLOWED BY WIDTH.

2.6. SLABS TO BE CONTINUOUSLY MOIST CURED FOR 7 DAYS MAINTAINING DAMPNESS AT ALL TIMES WITH CLEAR PLASTIC FILM AND WET SAND, OR CONTINUOUS IMMERSION. PVA & RESIN BASED CURING COMPOUNDS SHALL NOT BE USED.

2.7. MECHANICALLY VIBRATE ALL CONCRETE TO GIVE MAXIMUM COMPACTION WITHOUT SEGREGATION OF THE CONCRETE.

2.8. AT FOOTING INTERSECTIONS REINFORCEMENT SHALL EXTEND MIN. 40xBAR DIAMETERS INTO TRANSVERSE FOOTING.

2.9. NO HOLES, CHASES OR EMBEDMENT OF PIPES OTHER THAN THOSE SHOWN ON THE STRUCTURAL DRAWINGS SHALL BE MADE IN CONCRETE ELEMENTS WITHOUT PRIOR APPROVAL OF THE SUPERINTENDENT.

2.10. DIMENSIONAL TOLERANCES OF AS 3600 MODIFIED BY AS 3610 SHALL APPLY UNLESS OTHERWISE NOTED.

2.11. REINFORCEMENT IS REPRESENTED DIAGRAMATICALLY AND NOT NECESSARILY SHOWN IN TRUE PROJECTION.

2.12. SPLICES IN REINFORCEMENT SHALL BE MADE ONLY IN THE POSITIONS SHOWN OR AS OTHERWISE APPROVED BY THE SUPERINTENDENT.

2.13. WELDING OF REINFORCEMENT SHALL NOT BE PERMITTED WITHOUT THE APPROVAL OF THE SUPERINTENDENT.

2.14. ALL REINFORCEMENT SHALL BE WIRED TO AND SUPPORTED OF APPROVED CHAIRS AT A MAXIMUM SPACING OF 1m CENTRES BOTH WAYS TO PROVIDE THE CORRECT COVER.

2.15. REINFORCEMENT SYMBOLS:

N

-

DEFORMED BARS TO AS/NZS 4671 GRADE 500 MPa

R

-

STRUCTURAL GRADE PLAIN ROUND BAR TO AS/NZS 4671 GRADE 250 MPa

SL/RL

-

HARD DRAWN STEEL WIRE REINFORCING FABRIC TO AS/NZS 4671 GRADE 500 MPa

2.16. FORMWORK FOR FORMED CONCRETE SHALL BE STRIPPED AS REQUIRED BY THE FORMWORK CODE AND SHALL BE BACKPROPPED UNTIL SUCH TIME AS THE CONCRETE HAS GAINED ITS DESIGN STRENGTH (AS 3600 AND AS 3610 ALSO APPLY).

2.17. WHERE CONSTRUCTION LOADS ARE IMPOSED, ADEQUATE BACKPROPPING SHALL BE MAINTAINED UNTIL SUCH LOADS ARE REMOVED AND AS APPROVED BY THE SUPERINTENDENT.

2.18. FORMWORK DESIGN AND THE PROGRAMME OF CONCRETE POURS, STRIPPING AND SHORING SEQUENCES SHALL BE APPROVED BY THE SUPERINTENDENT.

2.19. PROVIDE DAMP PROOF MEMBRANE WHEN CONCRETE IS CAST AGAINST THE GROUND.

2.20. FORMWORK SHALL REMAIN IN POSITION FOR A MINIMUM PERIOD OF 28 DAYS. WHERE SLABS AND BEAMS ARE TO SUPPORT BRICKWORK OR OTHER NON-FLEXIBLE / BRITTLE FORMS OF CONSTRUCTION.

2.21. NO LOADS SHALL BE PLACED ON CANTILEVERED MEMBERS UNTIL REMOVAL OF TEMPORARY SUPPORTS.

2.22. DESIGN, ERECTION AND REMOVAL OF FORMWORK AND TEMPORARY SUPPORTS SHALL BE THE RESPONSIBILITY OF THE BUILDER.

2.23. THE FACES OF ALL CONCRETE OF WHICH NEW CONCRETE IS TO BE POURED SHALL BE THOROUGHLY SCABBLED AND CLEANED OF ANY DELETERIOUS MATERIAL.


2.24. PRIOR TO PLACEMENT OF SLAB ON GROUND, ALL TOP SOIL AND ANY LOOSE OR ORGANIC MATERIAL MUST BE REMOVED AND REPLACED BY AN APPROVED CONSOLIDATED FILLING MATERIAL COMPACTED TO A MINIMUM OF 98% MDD.
- 3.0 TREES AND LANDSCAPE NOTES:
- 3.1. WHERE TREE(S) EXIST WITHIN THE SITE AND/OR ADJOINING SITE(S) OR NEW TREES ARE PROPOSED, IT IS IMPORTANT TO ENSURE THAT THESE EXISTING OR PROPOSED TRESS DO NOT NEGATE THE PERFORMANCE OF THE FOOTING. A THUMB RULE IS 1.5 x THE MATURE HEIGHT OF THE TREE IS THE DISTANCE MEASURED FROM THE TREE TRUNK IS THE ZONE OF INFLUENCE OF THE TREE TO THE FOUNDATION. IN ALL CASES, A QUALIFIED ARBORIST WITH AQF5 QUALIFICATION SHOULD BE CONSULTED TO DETERMINE IF THE TREE ROOTS WILL NEGATE THE FOUNDATION IN ANYWAY AND APPROPRIATE MEASURES SUCH AS ROOT BARRIER OR REMOVAL OF THE TREE ETC. MAY BECOME NECESSARY TO GUARD THE FOOTINGS AGAINST ABNORMAL MOVEMENTS.

3.2. WHERE MORE THAN 10% OF THE EXISTING TREE ROOTS WILL BE DISTURBED / REMOVED BY THE NEW EARTHWORKS, A QUALIFIED ARBORIST WITH AQF5 QUALIFICATION SHOULD BE CONSULTED REGARDING STABILITY AND HEALTH OF THE AFFECTED TREE PRIOR TO UNDERTAKING THE EARTHWORK.

3.3. WHERE TREES AND OVER GROWN VEGETATION IS REMOVED ALLOW A PERIOD OF ATLEAST 3 MONTHS FOR THE SOIL TO REGAIN ITS NATURAL EQUILIBRIUM MOISTURE BEFORE CONSTRUCTION OF FOOTING.

3.4. ALL SOFT AND HARD LANDSCAPE SHOULD BE IN ACCORDANCE WITH THE GUIDELINES OF:

i) THE LATEST BSA SUBSIDENCE POLICY

ii) CSIRO'S FOUNDATION MAINTENANCE AND FOOTING PERFORMANCE: A HOME OWNERS GUIDE AND ALL LANDSCAPE SHOULD BE CERTIFIED BY A ARBORIST WITH AQF5 QUALIFICATIONS.
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| | | | |
| Index | Description | Approved by | Date |
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Elite Engineers Pvt. Ltd
Civil & Structural Engineers


CLIENT: -

PROJECT: BLOCK RETAINING WALL
MITCHELL’S ISLAND NSW 2430

JOB NUMBER
FV 036


A3

SCALE
N.T.S

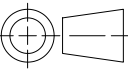THIRD ANGLE
PROJECTION

DRAWING
GENERAL NOTES 01

REV
0

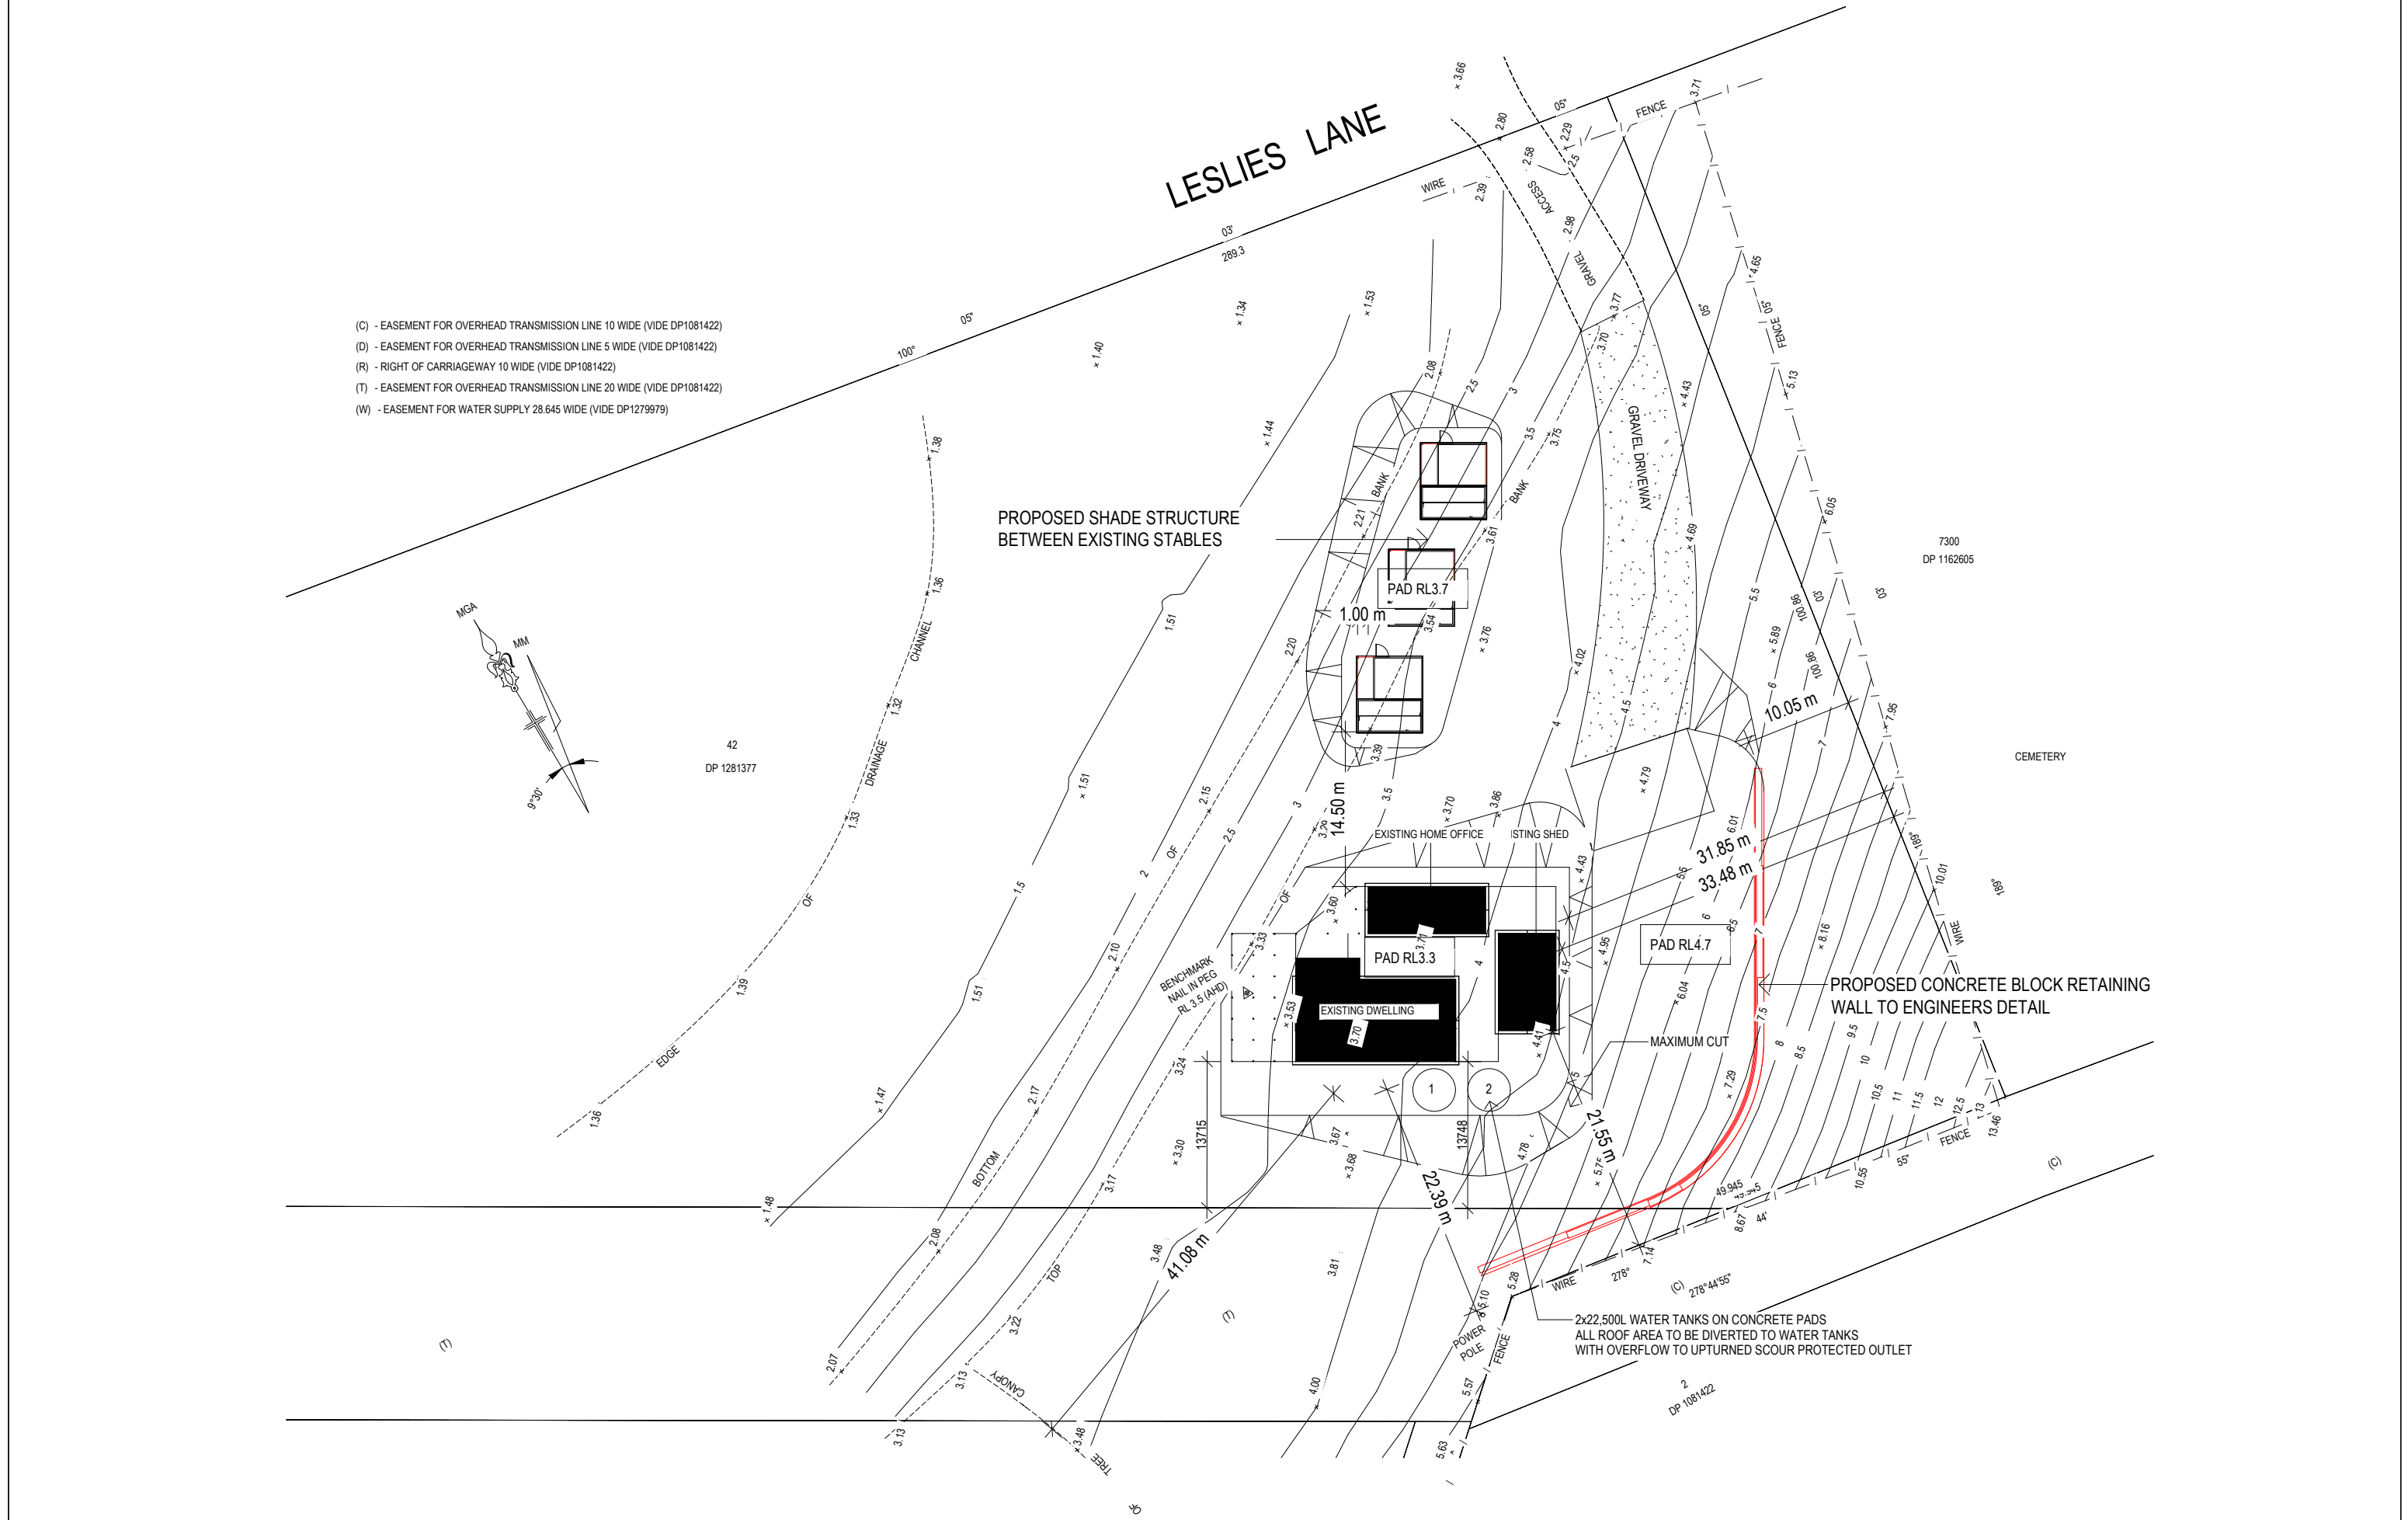

Index	Description	Approved by	Date

 ELITE CIVIL ENGINEERS	Elite Engineers Pvt. Ltd Civil & Structural Engineers	CLIENT: -	JOB NUMBER FV 036	A3	SCALE N.T.S	THIRD ANGLE PROJECTION 	REV 0
		PROJECT: BLOCK RETAINING WALL MITCHELL'S ISLAND NSW 2430	DRAWING RW LOCATION				



Site Area		
Name	Area	Percentage of Area Used
Site Remaining	50548.25 m ²	97.9%
Built Area	570.45 m ²	1.1%
Stables	162.48 m ²	0.3%
Hay Shed	180.00 m ²	0.3%
Barn Area	159.55 m ²	0.3%
Grand total: 5	51620.73 m ²	100.0%

JAKE JOHNSTON BUILDING DESIGN

MOB:0402689260

EMAIL:
jakejohnstonbuildingdesign@gmail.com

SUITE 5, RANATAN BUSINESS
CENTRE, BELGRAVE STREET,
KEMPSEY, NSW, 2440

ENGINEER

PROPOSED DWELLING

FOR THOMAS WORTH

AT LOT 42, DP1281377
24 RUPRECHTS
ROAD
MITCHELLS
ISLAND, NSW, 2430


STANDARD NOTES:
ALL ARCHITECTURAL DRAWINGS TO
BE READ IN CONJUNCTION WITH THE
STRUCTURAL ENGINEERS
DRAWINGS AND ALL OTHER
RELEVANT CONSULTANTS
DRAWINGS.
VERIFY ALL DIMENSIONS BEFORE
WORK COMMENCES.
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ACCORDANCE WITH THE RELEVANT
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AND THE BUILDING CODE OF
AUSTRALIA UNLESS OTHERWISE
SPECIFIED.


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TITLE	SITE PLAN DETAIL
PLAN	SHEDS & RETAINING WALL
DATE	05/03/25
SCALE	1 : 500
DRAWN	J.A.J

JOB No. _____ DRAWING No. _____

353-JJBD 04

Rev	Amendment	Date
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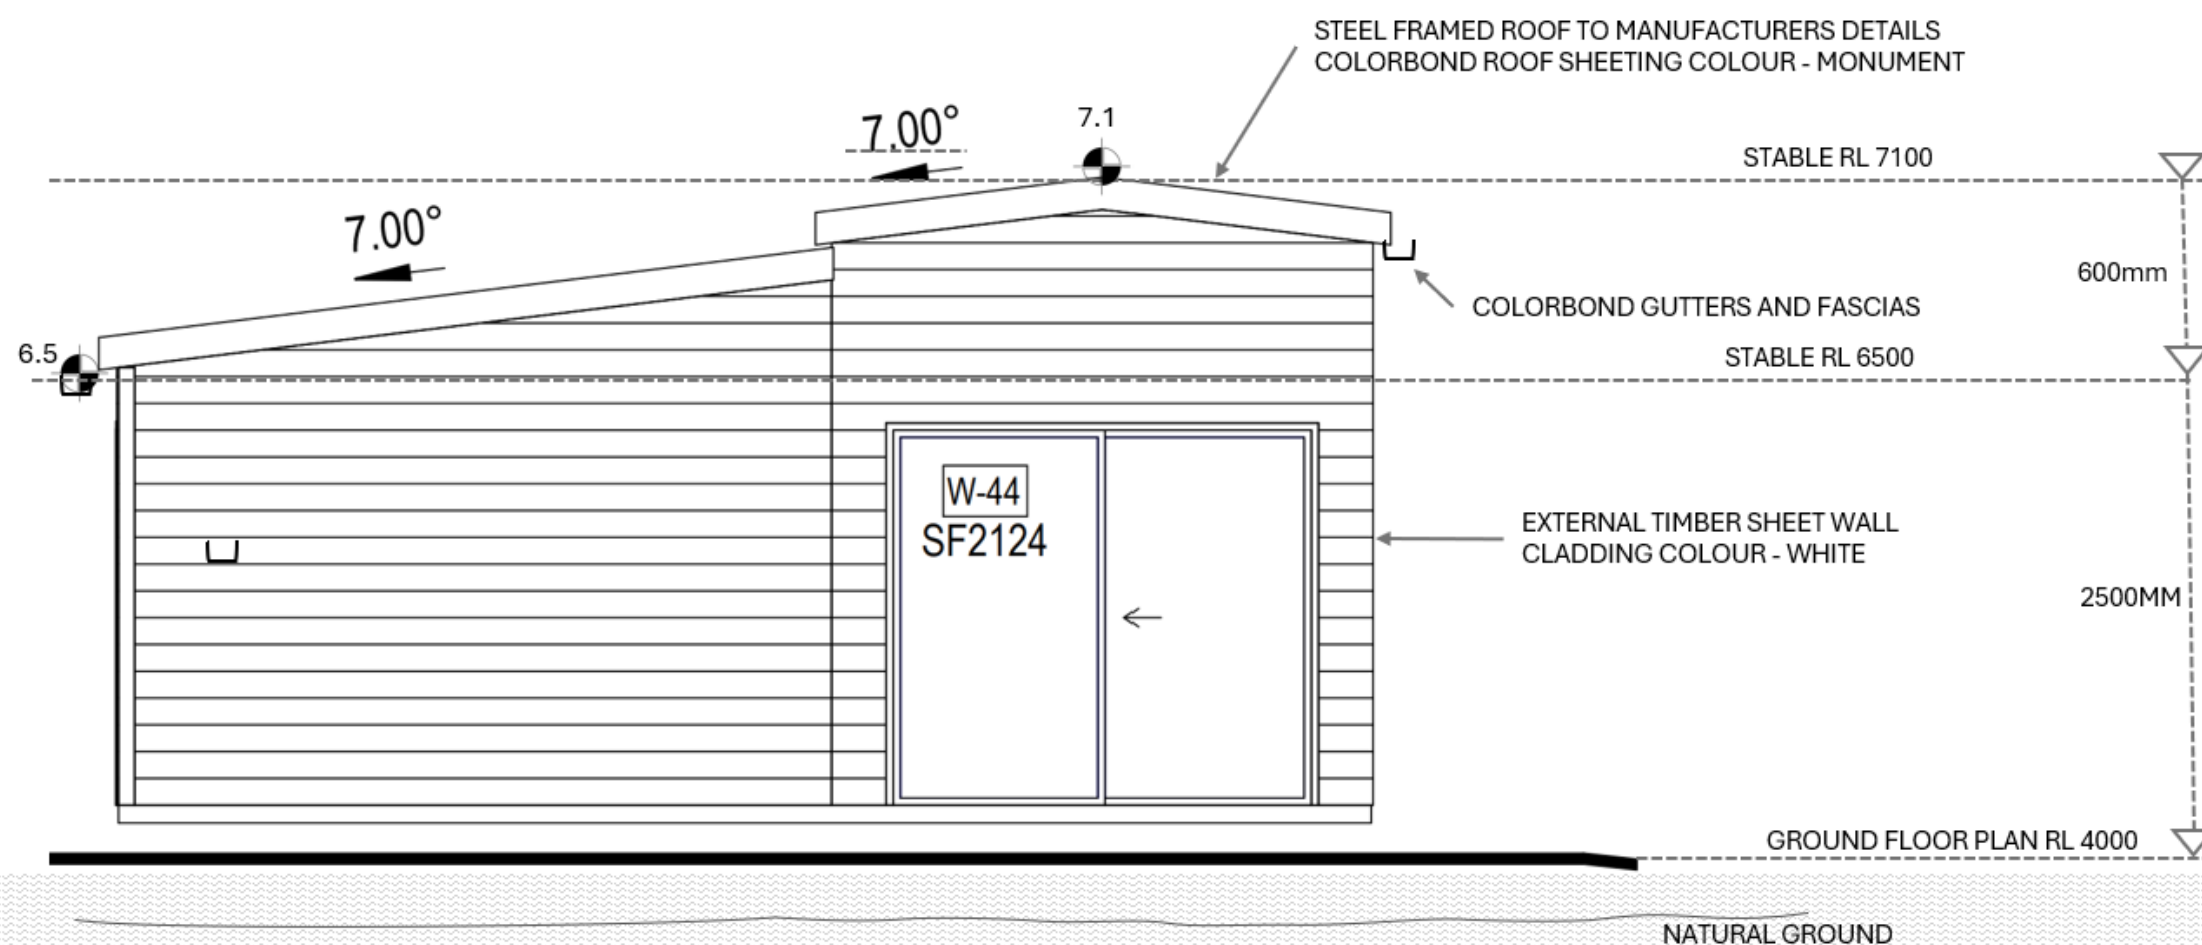
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DATE	05/03/25
SCALE	1 : 500
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JOB No. DRAWING No.

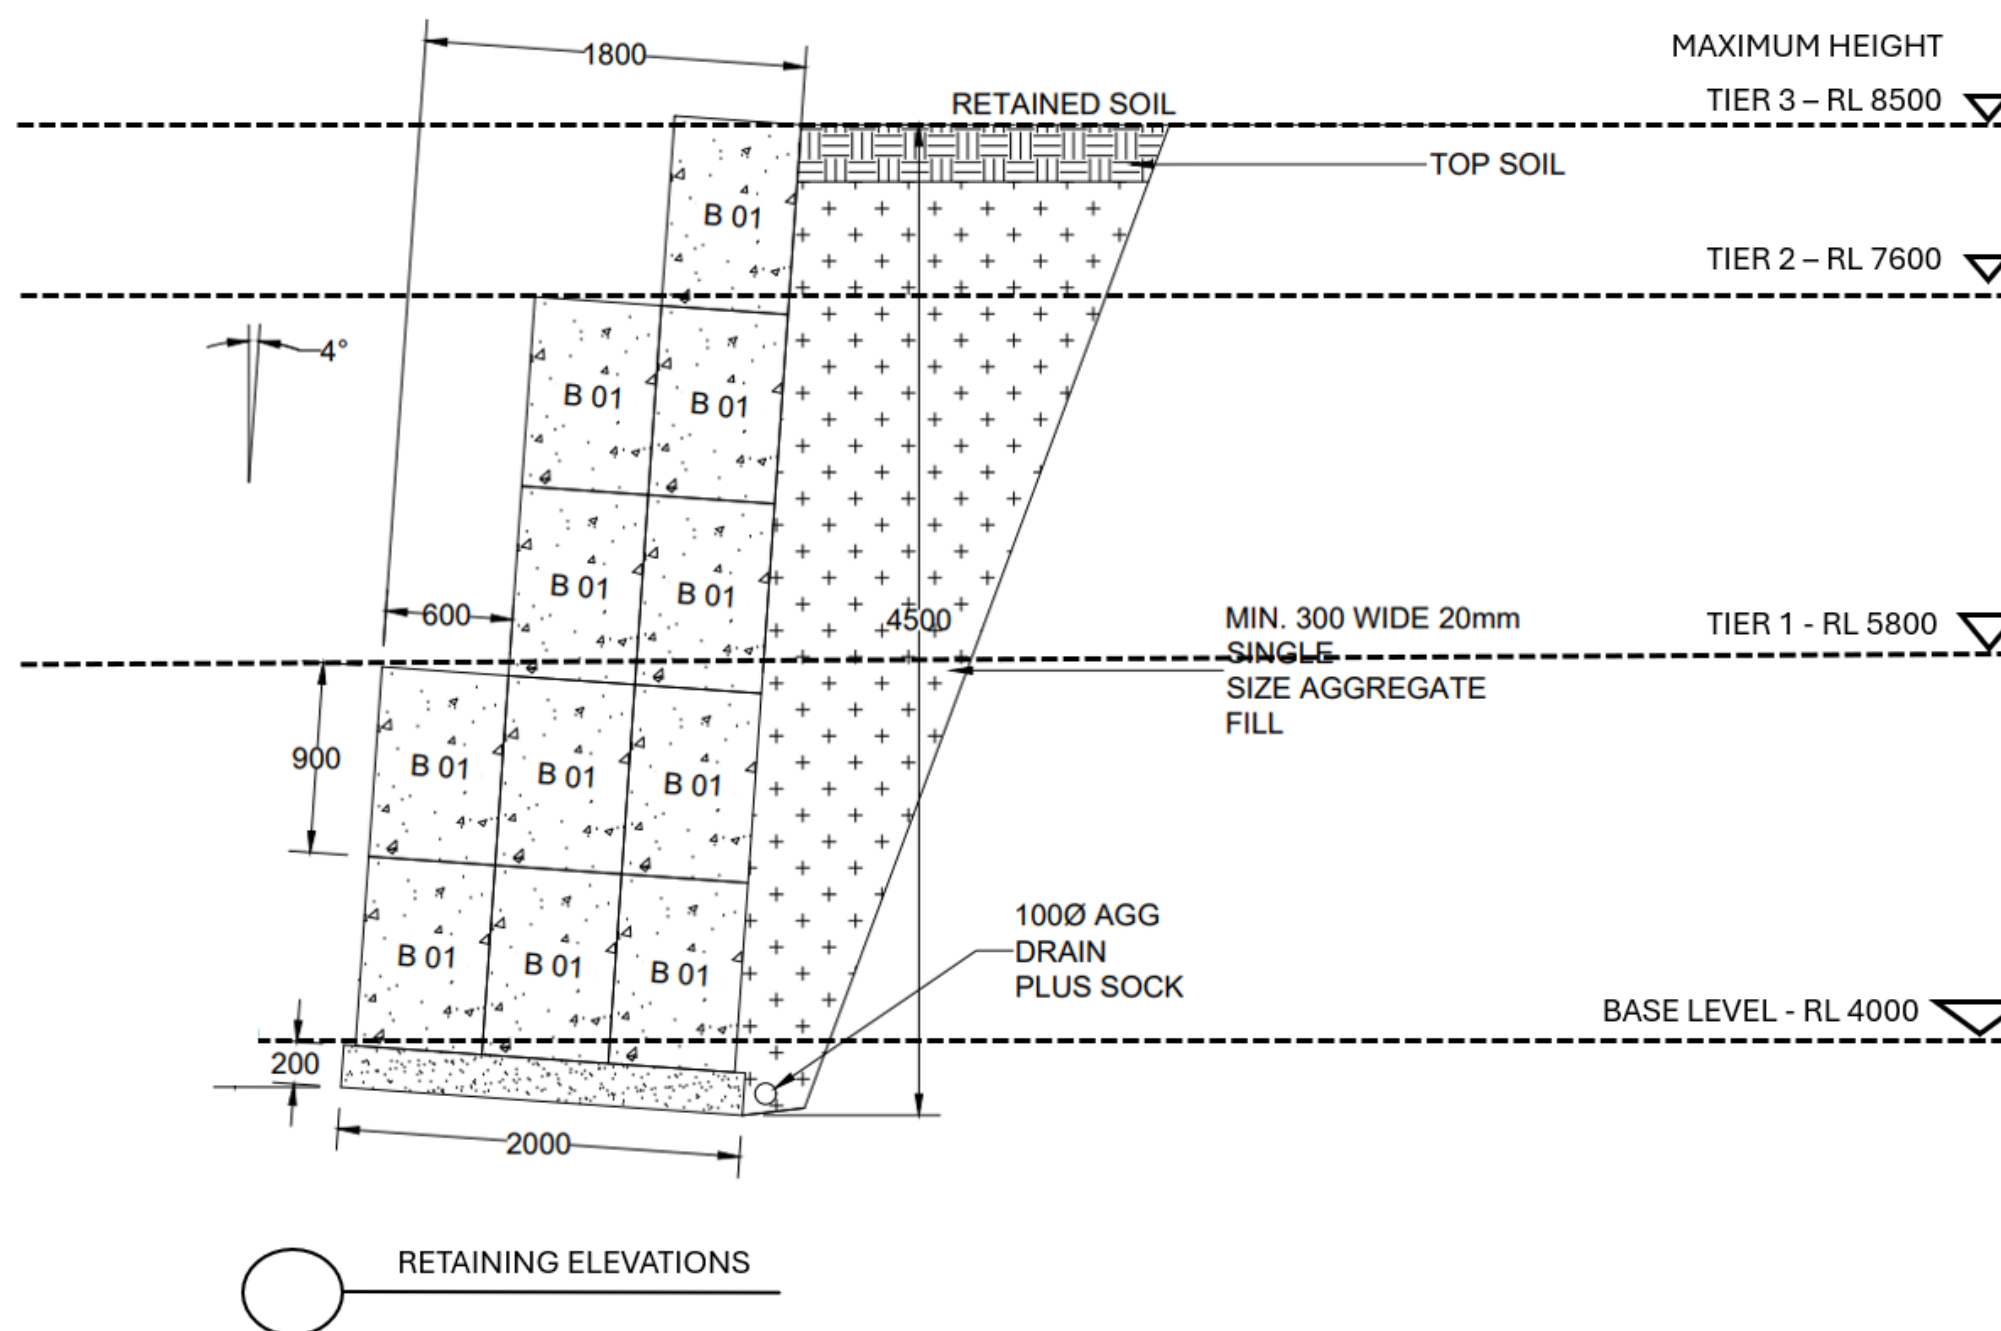353-JJBD 04

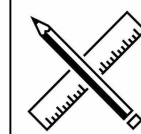
Rev	Amendment	Date
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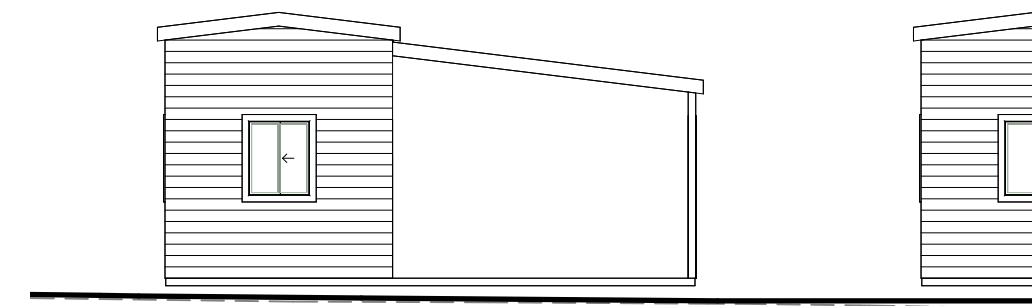
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NW-Stables Elevation


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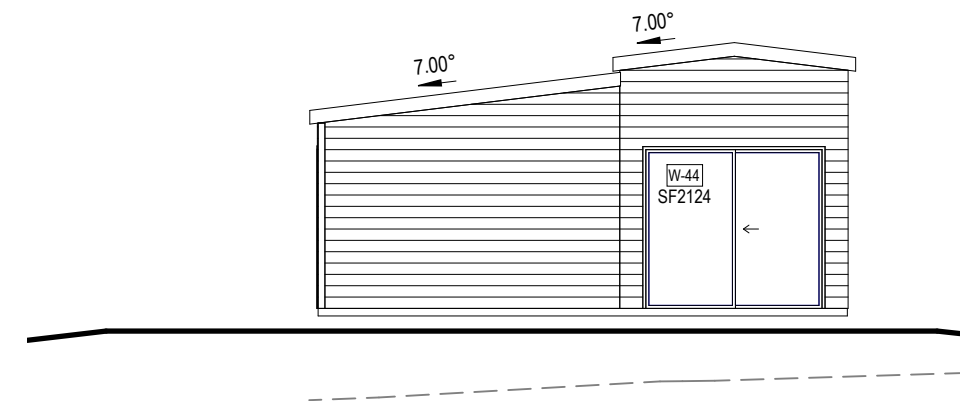
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Scale 1 : 100



2 SE-Stables Elevation
Scale 1 : 100

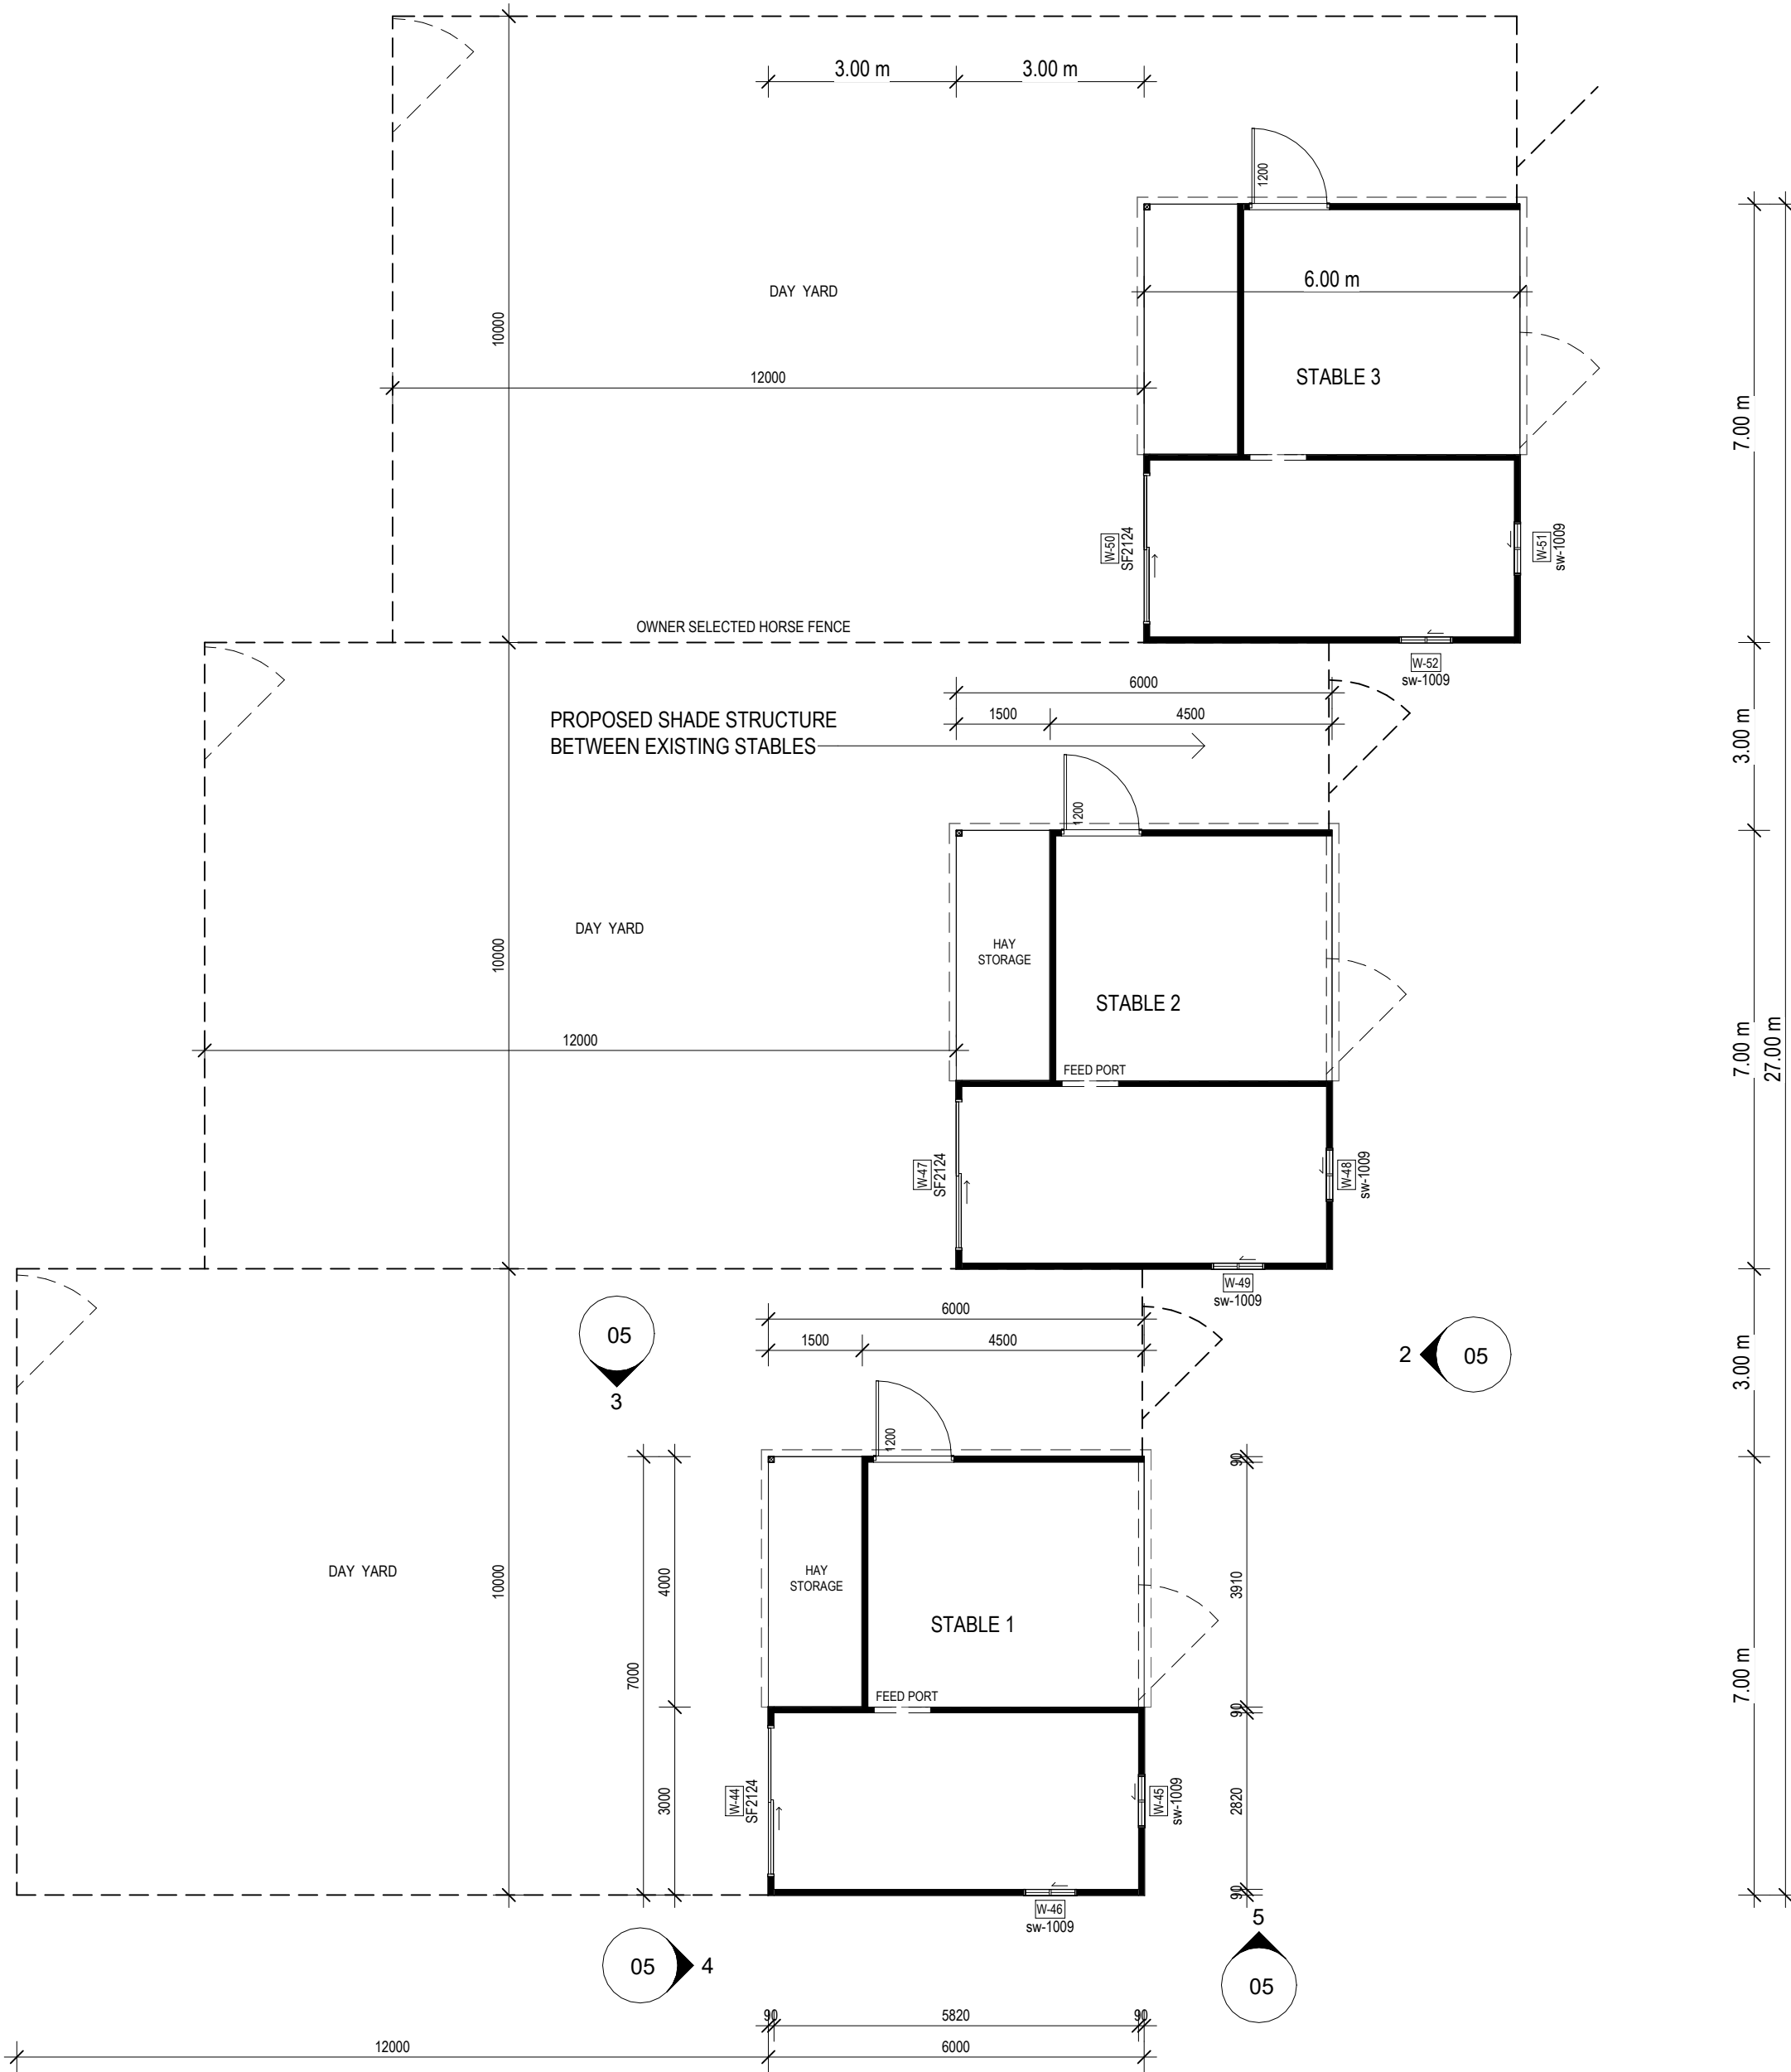

3 NE-Stables Elevation
Scale 1 : 100

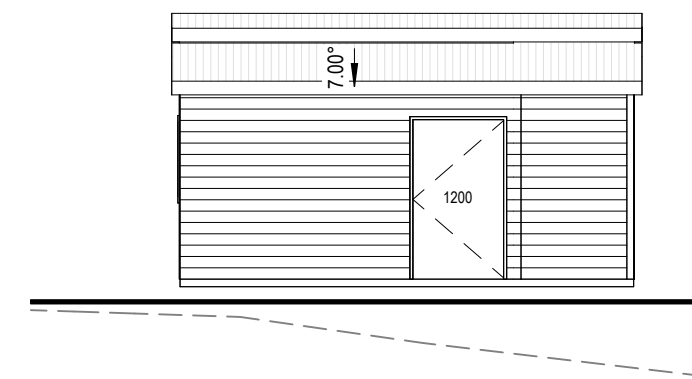

4 NW-Stables Elevation
Scale 1 : 100



5 SW-Stables Elevation
Scale 1 : 100



JAKE JOHNSTON
BUILDING DESIGN

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PROPOSED DWELLING
FOR THOMAS WORTH
AT LOT 42, DP1281377
24 RUPRECHTS ROAD
MITCHELLS ISLAND,
NSW, 2430

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BASIX
CERT. No. N/A
TITLE STABLES FLOOR
PLAN
PLAN SHEDS &
RETAINING WALL

DATE 05/03/25
SCALE 1 : 100
DRAWN J.A.J
JOB No. DRAWING No.
353-JJBD 05

Rev	Amendment	Date
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